0

STATE OF ILLINOIS

INDEX OF SHEETS

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EROSION CONTROL AND GRADING PLAN

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DEPARTMENT OF TRANSPORTATION

PLANS FOR PROPOSED AT-GRADE RAILROAD CROSSING GRADE CROSSING PROTECTION FUND

STANDARDS (IN PROPOSAL)

STANDARD SYMBOLS, ABBREVIATIONS AND PATTERNS AREAS OF REINFORCEMENT BARS

001001-02 001006 DECIMAL OF AN INCH AND OF A FOOT 280001-07 TEMPORARY EROSION CONTROL SYSTEMS

METAL FLARED END SECTION FOR PIPE CULVERTS 542401-04

635001-02 DELINEATORS

TRAFFIC CONTROL DEVICES 701901-09

720011-01 METAL POSTS FOR SIGNS, MARKERS AND DELINEATORS

TYPICAL APPLICATION OF TRAFFIC CONTROL DEVICES FOR CONSTRUCTION ON RURAL LOCAL HIGHWAYS

WHITES CROSSING AVENUE (TR 21) OVER I.M.R.R. SECTION 19-05117-00-RR **MENARD COUNTY**


UTILITY COMPANIES:

AMEREN ILLINOIS - (NORTH #6 EXECUTIVE DRIVE COLLINSVILLE, IL 62234 PHONE: (618)-301-5327 CONTACT: NATHAN HILL

ATT/DISTRIBUTION 1000 COMMERCE DRIVE OAK BROOK, ILLINOIS 60523 CONTACT: G11629@ATT.COM

MENARD ELECTRIC COOP 14300 STATE HWY 97 PETERSBURG, IL 62675 PHONE: (217)-632-7746 CONTACT: BRADY SMITH

| NET LENGTH OF BL A = | 465.00 | FEET | (0.088) | ΜI |
|----------------------|--------|------|---------|----|
| NET LENGTH OF BL B = | 127.04 | FEET | (0.024 | ΜI |
| NET LENGTH = | 592.04 | FEET | (0.112 | MI |

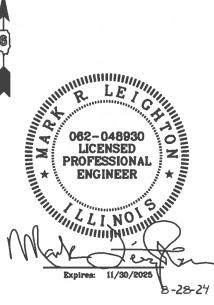

LOCATION OF SECTION INDICATED THUS: -

FUNCTIONAL CLASSIFICATION = LOCAL ROAD


ADT = 25

DESIGN SPEED = 30 MPH **3R GUIDELINES**

Released For

Sastenber 10 20 24

STATE OF ILLINOIS **DEPARTMENT OF TRANSPORTATION**

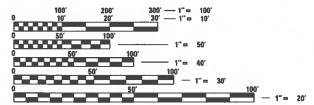


ENGINEERING SCALES, REDUCED SIZED PLANS WILL NOT CONFORM TO STANDARD SCALES. IN MAKING MEASUREMENTS ON REDUCED PLANS, THE ABOVE SCALES MAY BE USED.

JOINT UTILITY LOCATION INFORMATION FOR EXCAVATION 1-800-892-0123

OR 811

PROJECT MANAGER: MARK R. LEIGHTON, P.E., P.L.S.



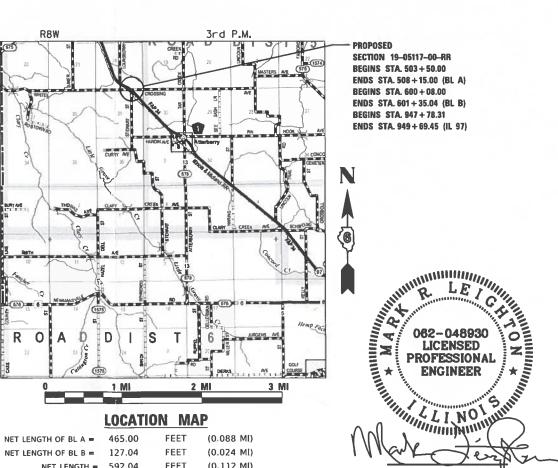

THIS WORK CONSISTS OF CONSTRUCTING A RELOCATED AT-GRADE RAILROAD CROSSING PERPENDICULAR TO ILLINOIS MIDLAND RAILROAD AND IL 97 THAT INCLUDES ROADWAY GEOMETRICS AND DRAINAGE IMPROVEMENTS ALONG WITH INCIDENTAL WORK

GENERAL NOTES

- 1. EXCEPT AS NOTED ON THE PLANS, PAVEMENT GRADES SHOWN ARE AT THE TOP OF PAVEMENT SURFACES.
- 2. ALL ELEVATIONS ARE BASED ON NAVD 88-DATUM
- 3. WHERE PERMANENT SURVEY MARKERS ARE ENCOUNTERED, THE ENGINEER SHALL BE NOTIFIED BEFORE SUCH MONUMENTS ARE DISTURBED. THE CONTRACTOR SHALL PROTECT AND PRESERVE ALL PROPERTY MARKERS AND MONUMENTS UNTIL THE OWNER AND AN AUTHORIZED SURVEYOR HAS WITNESSED OR OTHERWISE REFERENCED THE LOCATION.
- 4. ABANDONED UNDERGROUND UTILITIES THAT CONFLICT WITH CONSTRUCTION SHALL BE DISPOSED OF OUTSIDE THE LIMITS OF THE RIGHT OF WAY ACCORDING TO ARTICLE 202.03 OF THE STANDARD SPECIFICATIONS AND AS DIRECTED BY THE ENGINEER. THIS WORK WILL NOT BE PAID FOR SEPARATELY BUT SHALL BE INCLUDED IN THE COST OF CONTRACT ITEMS INVOLVED.
- 5. THE LOCATIONS OF EXISTING WATER MAINS, GAS MAINS, SEWERS, ELECTRIC POWER LINES, TELEPHONE LINES AND OTHER UTILITIES AS SHOWN ON THE PLANS ARE BASED ON THE BEST INFORMATION AVAILABLE, BUT THEY ARE NOT GUARANTEED. UNLESS ELEVATIONS ARE SHOWN. ALL UTILITY LOCATIONS SHOWN ON THE CROSS SECTIONS ARE BASED ON THE APPROXIMATE DEPTH SUPPLIED BY THE UTILITY COMPANY. IT SHALL BE THE CONTRACTOR'S RESPONSIBILITY TO ASCERTAIN THEIR EXACT LOCATION FROM THE UTILITY COMPANIES AND BY FIELD INSPECTION.
- 6. THE FOLLOWING APPLICATION RATES HAVE BEEN USED IN CALCULATING PLAN QUANTITIES:
 AGGREGATE BASE COURSE: 2.05 TONS/CU YD
 BITUMINOUS MATERIALS (PRIME COAT): 0.25 LB/SQ FT
 BITUMINOUS MATERIALS (TACK COAT): 0.025 LB/SQ FT
 HOT-MIX ASPHALT: 112 LBS/SQ YD/IN

TEMPORARY EROSION CONTROL SEEDING: 100 LB/ACRE

RIPRAP: 1.50 TONS/CU YD

- 7. THE CONTRACTOR'S OPERATIONS AND TEMPORARY STORAGE ACTIVITIES SHALL BE LIMITED TO THE WORK AREA AND/OR CONSTRUCTION LIMITS. ANY ADDITIONAL STAGING AREAS ADJACENT TO THE PROJECT AREA ARE SUBJECT TO PRIOR APPROVAL BY THE ENGINEER AND MUST NOT CONFLICT WITH EXISTING SIDE ROADS, INTERSECTIONS, DRIVEWAYS, OR DRAINAGE. ALL OPERATIONS SHALL BE SUBJECT TO REGULATORY REQUIREMENTS PERMITTED FOR THIS PROJECT. NO ADDITIONAL COMPENSATION WILL BE ALLOWED TO THE CONTRACTOR FOR COMPLIANCE WITH THE ABOVE REQUIREMENTS.
- 8. DISTURBED AREAS SHALL RECEIVE PERMANENT STABILIZATION WITHIN 7 DAYS OF COMPLETION OF CONSTRUCTION ACTIVITIES. TEMPORARY STABILIZATION OF WORK AREAS IS REQUIRED FOR ALL AREAS REMAINING UNDISTURBED FOR 14 DAYS, UNLESS WORK RESUMES PRIOR TO 21 DAYS. TEMPORARY STABILIZATION MUST BE APPROVED BY THE ENGINEER.
- THE CONTRACTOR SHALL USE CARE IN ALL REMOVAL ACTIVITIES NEAR ALL EXISTING ITEMS WHICH WILL
 REMAIN. ANY DAMAGE DONE TO EXISTING ITEMS BY THE CONTRACTOR SHALL BE REPAIRED AT THE
 CONTRACTORS EXPENSE.
- 10. THE CONTRACTOR SHALL RELOCATE OR REMOVE AND REPLACE ALL SIGNS THAT INTERFERE WITH THE CONSTRUCTION OPERATIONS AND TEMPORARILY RESET ALL SUCH SIGNS DURING ALL STAGES OF CONSTRUCTION AS DIRECTED BY THE ENGINEER. THE ENGINEER WILL DETERMINE THE PERMANENT LOCATION FOR EXISTING SIGNS TO BE RE-ERECTED.
- 11. CONTRACTOR SHALL FOLLOW CONSTRUCTION REQUIREMENTS OF SECTION 611 WHEN EXISTING FIELD TILE IS ENCOUNTERED. ALL FIELD TILES ENCOUNTERED SHALL BE CAREFULLY PRESERVED, REPAIRED AND CONNECTED TO THE PROPOSED DRAINAGE STRUCTURES, SEWERS OR DITCHES AS DIRECTED BY THE ENGINEER. PAYMENT FOR THIS WORK SHALL BE INCLUDED IN THE VARIOUS DRAINAGE ITEMS OR AS DIRECTED BY THE ENGINEER.
- 12. EMBANKMENTS ON HILLSIDES OR SLOPES SHALL BE CONSTRUCTED ACCORDING TO ARTICLE 205.03.
- 13. CONTRACTOR SHALL INSTALL ALL EROSION CONTROL MEASURES PRIOR TO STARTING ANY OTHER CONSTRUCTION WORK AT SITE.

GENERAL NOTES (CONT'D)

- 14. THE CONTRACTOR SHALL VERIFY THE LENGTH OF REQUIRED PIPE CULVERTS PRIOR TO ORDERING.
- 15. BITUMINOUS ROADWAY SURFACE TO BE REMOVED WILL BE INCLUDED IN EARTH EXCAVATION QUANTITY.

IMRR/G&W RAILROAD GENERAL NOTES

- 1. CONTRACTOR TO NOTIFY G&W PUBLIC PROJECTS DEPARTMENT 30 DAYS PRIOR TO STARTING CONSTRUCTION.
- G&W FLAGGING SERVICES WILL BE REQUIRED FOR ALL WORK WITHIN G&W RIGHT-OF-WAY OR ANY WORK THAT HAS A "POTENTIAL TO FOUL".
- 3. THE CONTRACTOR MUST NOT USE THE RAILROAD RIGHT OF WAY FOR STORAGE OF MATERIALS OR EQUIPMENT DURING CONSTRUCTION. THE RAILROAD RIGHT OF WAY MUST REMAIN CLEAR AT ALL TIMES.

 THE CONTRACTOR MUST PLAN AND PERFORM THE WORK IN A MANNER SUCH THAT THE RAILROAD TRACKS AT THE PROJECT LOCATION REMAIN FULLY CAPABLE OF OPERATING RAIL TRAFFIC THROUGHOUT THE WORK PERIOD AND RAIL TRAFFIC IS NOT DELAYED OR OTHERWISE IMPACTED DUE TO THE WORK BEING PERFORMED.
- 4. ALL WORK PERFORMED ON, ABOVE OR ADJACENT TO RAILROAD PROPERTY SHALL BE IN ACCORDANCE WITH TO THE PUBLIC PROJECT MANUAL, CURRENT EDITION. WORK PLANS SHALL BE SUBMITTED FOR REVIEW TO THE RAILROAD FOR ACCESS, SOIL AND WATER MANAGEMENT, BALLAST PROTECTION, EXCAVATION, HOISTING, DEMOLITION, AND ALL OTHER WORK THAT PRESENTS THE POTENTIAL TO AFFECT RAILROAD PROPERTY OR OPERATIONS. ALL WORK PLANS SHALL BE PREPARED AND SUBMITTED TO THE RAILROAD IN ADHERENCE WITH THE PUBLIC PROJECT MANUAL, SECTION 1.11 CONSTRUCTION SUBMISSION CRITERIA.
- 5. THE CONTRACTOR WILL BE REQUIRED TO REACH OUT TO G&W REAL ESTATE FOR A ROE APPLICATION AND AGREEMENT FOR WORK TO TAKE PLACE ON THE G&W ROW.

 HERE IS THE WEBSITE FOR ROE INFORMATION: https://www.gwrr.com/real_estate/accessing_property
- 6. THE CONTRACTOR AND THE AGENCY MUST PROVIDE INSURANCE TO THE RAILROAD AS WILL BE DETERMINED AT THIS LOCATION BASED ON THE SCOPE OF IMPACT PER SECTION 1.06 OF THE RAILROAD PUBLIC PROJECT MANUAL (PPM)
- PIPELINE CONSTRUCTION UNDER RAILROAD SHALL BE DONE IN ACCORDANCE TO RAILROAD PUBLIC PROJECT MANUAL (PPM), LAST REVISED APRIL 2019.
- 8. TEMPORARY CONSTRUCTION CLEARANCE ENSURE ALL FALSEWORK, BRACING OR FORMS HAVE A MINIMUM HORIZONTAL CLEARANCE OF 12 FEET MEASURED PERPENDICULAR TO THE CENTERLINE OF THE NEAREST TRACK.
- 9. MEANS AND METHODS THE CONTRACTOR SHALL DEVELOP A DETAILED SUBMISSION INDICATING THE PROGRESSION OF WORK WITH SPECIFIC TIMES WHEN TASKS WILL BE PERFORMED FOR WORK ACTIVITIES THAT ARE ON OR IN THE VICINITY OF THE RAILROAD PROPERTY. THIS SUBMISSION MAY REQUIRE A WALKTHROUGH AT WHICH TIME RAILROAD AND/OR THE REPRESENTATIVE WILL BE PRESENT. WORK WILL NOT BE PERMITTED TO COMMENCE UNTIL THE CONTRACTOR HAS PROVIDED RAILROAD WITH A SATISFACTORY PLAN THAT THE PROJECT WILL BE UNDERTAKEN WITHOUT SCHEDULING, PERFORMANCE OR SAFETY RELATED ISSUES. PROVIDE A LISTING OF THE ANTICIPATED EQUIPMENT TO BE USED, THE LOCATION OF ALL EQUIPMENT TO BE USED AND ENSURE A CONTINGENCY PLAN OF ACTION IS IN PLACE SHOULD A PRIMARY PIECE OF EQUIPMENT MALFUNCTION. ALL WORK IN THE VICINITY OF RAILROAD PROPERTY THAT HAS THE POTENTIAL OF AFFECTING RAILROAD TRAIN OPERATIONS MUST BE SUBMITTED AND APPROVED BY RAILROAD PRIOR TO WORK BEING PERFORMED. THIS SUBMISSION WILL ALSO INCLUDE A DETAILED NARRATIVE DISCUSSING THE COORDINATION OF PROJECT SAFETY ISSUES BETWEEN CONTRACTOR, RAILROAD AND THE REPRESENTATIVE. THE NARRATIVE SHALL ADDRESS PROJECT LEVEL COORDINATION AND DAY TO DAY, SPECIFIC WORK OPERATIONS INCLUDING CRANE AND EQUIPMENT OPERATIONS, ERECTION PLANS AND TEMPORARY WORKS.
- 10. ERECTION PROCEDURES, EXCAVATION AND SHORING PROCEDURES ARE REQUIRED TO BE SUBMITTED TO RAILROAD, OR THE REPRESENTATIVE, IN ACCORDANCE WITH THE RAILROAD PUBLIC PROJECT MANUAL

IMRR/G&W RAILROAD GENERAL NOTES (CONT'D)

PREPARATION OF SUBMISSIONS, AS IT CONTAINS SPECIFIC REQUIREMENTS THAT COULD IMPACT THE CONTRACTOR'S MATERIAL SELECTION AND METHODS OR OPERATIONS FOR WORK NEAR THE RAILROAD.


REVISIONS TO CONTRACTOR SUBMISSIONS MAY NOT BE FIELD APPROVED. ANY DEVIATION(S) FROM A PREVIOUSLY ACCEPTED PLAN INCLUDING EQUIPMENT SUBSTITUTIONS WILL REQUIRE A FORMAL RESUBMISSION OF THE PROCEDURE FOR REVIEW AND ACCEPTANCE PRIOR TO PERFORMING ANY WORK. A PROFESSIONAL ENGINEER IN THE STATE IN WHICH THE WORK IS PERFORMED MUST SIGN AND SEAL THE PLANS.

- 11. CONSTRUCTION SCHEDULE SUBMIT A DETAILED CONSTRUCTION SCHEDULE FOR THE DURATION OF THE PROJECT CLEARLY INDICATING THE TIME PERIODS WHILE WORKING ON AND AROUND RAILROAD RIGHT-OF-WAY. AS THE WORK PROGRESSES, THIS SCHEDULE SHALL BE UPDATED AND RESUBMITTED AS NECESSARY TO REFLECT CHANGES IN WORK SEQUENCE, DURATION AND METHOD, ETC.
- 12. EMERGENCY ACTION PLAN SUBMIT AN EMERGENCY ACTION PLAN INDICATING THE LOCATION OF THE SITE, CONTACT NUMBERS, ACCESS TO THE SITE, INSTRUCTIONS FOR EMERGENCY RESPONSE AND LOCATION OF THE NEAREST HOSPITALS. THIS PLAN SHOULD COVER ALL ITEMS REQUIRED IN THE EVENT OF AN EMERGENCY AT THE SITE INCLUDING FIRE SUPPRESSION. COORDINATE THE EMERGENCY ACTION PLAN WITH THE SAFETY RELATED DISCUSSION OF THE MEANS AND METHODS SUBMISSION DISCUSSED ABOVE. THE PLAN SHOULD ALSO INCLUDE A METHOD TO PROVIDE THIS INFORMATION TO EACH PROJECT WORKER FOR EACH DAY ON SITE.
- 13. THE CONTRACTOR MUST ENSURE THAT PROPER EROSION CONTROL IS IMPLEMENTED ON AND ADJACENT TO RAILROAD RIGHT-OF-WAY DURING CONSTRUCTION. THE CONTRACTOR MUST PREVENT SILT AND DEBRIS ACCUMULATION IN THE RAILROAD ROADBED, DITCHES AND OTHER RAILROAD FACILITIES. THE CONTRACTOR MAY BE REQUIRED TO SUBMIT A DETAILED EROSION CONTROL PLAN FOR REVIEW AND ACCEPTANCE BY RAILROAD OR THEIR REPRESENTATIVE PRIOR TO PERFORMING ANY WORK.
- 14. CONTRACTOR ACCESS WILL BE LIMITED TO THE IMMEDIATE PROJECT AREA ONLY. THE RAILROAD RIGHT-OF-WAY OUTSIDE THE PROJECT AREA MAY NOT BE USED FOR CONTRACTOR ACCESS TO THE PROJECT SITE AND NO TEMPORARY AT-GRADE CROSSINGS WILL BE ALLOWED WITHOUT WRITTEN APPROVAL FROM RAILROAD.
- 15. THE CONTRACTOR MAY NOT USE RAILROAD RIGHT-OF-WAY FOR STORAGE OF MATERIALS OR EQUIPMENT DURING CONSTRUCTION WITHOUT PRIOR RAILROAD APPROVAL. THE RAILROAD RIGHT-OF-WAY MUST REMAIN CLEAR FOR RAILROAD USE AT ALL TIMES. EQUIPMENT MAY NOT BE POSITIONED TO BLOCK THE RAILROAD ACCESS ROAD, TRACK AREA OR ANY PART OF THE RAILROAD RIGHT-OF-WAY WITHOUT PRIOR RAILROAD APPROVAL.


COMMITMENTS

1. THIS PROJECT HAS NO COMMITMENTS.

| SER NAME = bjohnson | DESIGNED - | BJJ | REVISED | = |
|-------------------------------|------------|-----------|---------|---|
| | DRAWN - | GSJ | REVISED | = |
| LOT SCALE = 1200.0000 ' / ft. | CHECKED - | MRL | REVISED | = |
| LOT DATE = 8/28/2024 | DATE - | 8/28/2024 | REVISED | - |

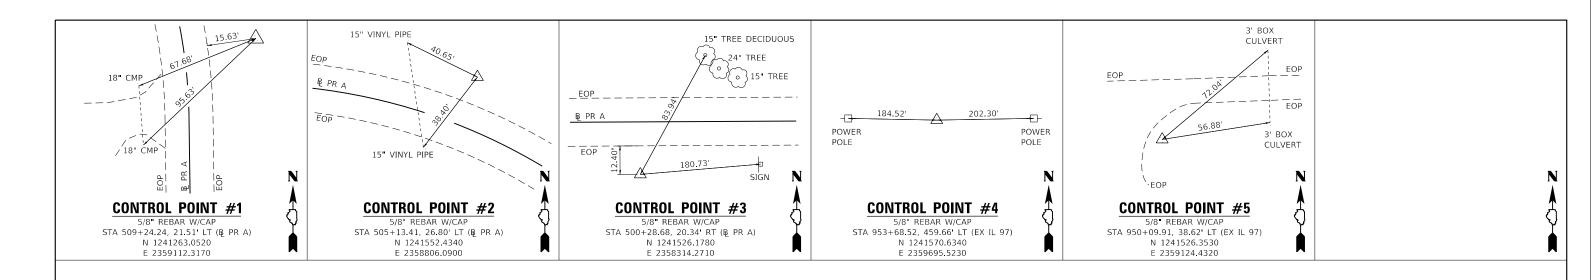


BM -1 STA. 951+52.69, 24.81' RT (EX IL 97) HEADWALL OF BOX CULVERT ON WEST SIDE OF ST. HWY 97 CHISELED SQUARE AT CENTER OF HEADWALL FIRST BOX CULVERT S. OF INTERSECTION ELEV. = 587.777

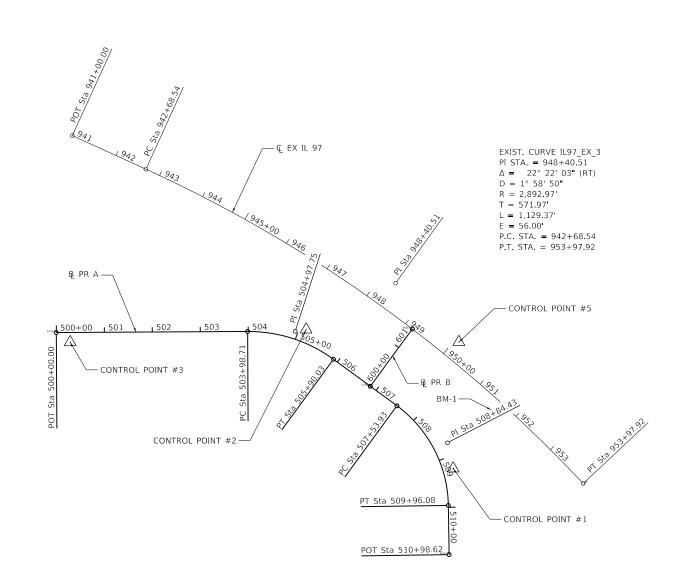

BL PR A - REFERS TO CL WHITES CROSSING AVE. (STA. 500+00.00 TO STA. 503+98.71)
AND CL STEWART STREET (STA. 503+98.71 TO STA. 510+98.62).

BL PR B - REFERS TO CL WHITES CROSSING AVE. (STA. 600+08.00 TO STA. 601+35.04).

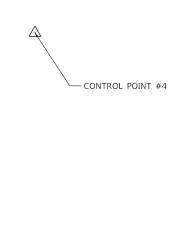

100 200 300 SCALE IN FEET

design firm no. 184001036 **whks** engineers + planners + land surveyors

PROP. CURVE BL_A1 PI STA. = 504+97.75 $\Delta = 36^{\circ} 32' 17" (RT)$

P.C. STA. = 503+98.71 P.T. STA. = 505+90.03

PROP. CURVE BL_A2 PI STA. = 508+84.43 $\Delta = 52^{\circ} 57' 04" (RT)$ D = $21^{\circ} 52' 00"$ R = 262.02'

P.C. STA. = 507+53.93

P.T. STA. = 509+96.08

T = 130.50' L = 242.15' E = 30.70'

D = 19° 05' 55" R = 300.00' T = 99.04'

L = 191.31E = 15.92

| USER NAME = bjohnson | DESIGNED - | BJJ | REVISED - |
|--------------------------------|------------|-----------|-----------|
| | DRAWN - | GSJ | REVISED - |
| PLOT SCALE = 2400.0000 ' / ft. | CHECKED - | MRL | REVISED - |
| PLOT DATE = 8/28/2024 | DATE - | 8/28/2024 | REVISED - |

MENARD COUNTY HIGHWAY DEPARTMENT

SCALE: 1" = 100'

| / | ALIGNMENT, TIES, & BENCHMARKS DETAILS | T.R. RTE | SECTION | COUNTY | TOTAL SHEETS | SHEE NO. |
|---|---------------------------------------|-------------|-----------------|------------------|-----------------|-------------|
| | WHITES CROSSING AVENUE | 21 | 19-051117-00-RR | MENARD | 43 | 3 |
| | WINIES CHOSSING AVENUE | | | CONTRA | CT NO. | |
| | SHEET 1 OF 2 SHEETS STA. TO STA. | | ILLINOIS E | FED. AID PROJECT | | |

```
Beginning chain BL_A description
                           N 1,241,546.3636 E 2,358,285.4805 Sta 500+00.00
Point BLA001
Course from BLA001 to PC BL_A1 N 89° 41' 02.92" E Dist 398.7144
                                           Curve Data
Curve BL_A1
P.I. Station
                         504+97.75 N
36° 32' 16.60' (RT)
19° 05' 54.94"
99.0353
191.3122
300.0000
                                                       1,241,549.1075 E 2,358,783.2227
Delta
Degree
Tangent
Length
Radius
                             300.0000
15.9240
188.0870
15.1214
503+98.71 N
505+90.03 N
 External
 External =
Long Chord =
Mid. Ord. =
P.C. Station
P.T. Station
C.C.
                                                    1,241,548.5616 E
1,241,490.5859 E
1,241,248.5661 E
Back = N 89° 41' 02.92" E
Ahead = S 53° 46' 40.48" E
Chord Bear = S 72° 02' 48.78" E
Course from PT BL_A1 to BLA002 S 53° 46' 40.48" E Dist 95.0294
Point BLA002 N 1,241,434.4314 E 2,358,939.7810 Sta 506+85.06
Course from BLA002 to PC BL_A2 S 53° 46' 40.48" E Dist 68.8710
                                           Curve Data
Curve BL A2
P.I. Station
Delta =
Degree =
Tangent =
Length =
Radius =
External =
                        508+84.43 N
52° 57' 03.87* (RT)
21° 52' 00.23"
130.5000
242.1536
262.0226
30.6993
233.6276
27.4797
507+53.93 N
509+96.08 N
                                                      1,241,316.6198 E 2,359,100.6201
 External
Long Chord =
Long Chord =
Mid. Ord. =
P.C. Station
P.T. Station
C.C.
Back = S
                                                     1,241,393.7344 E
1,241,186.1334 E
1,241,182.3523 E
C.C. N
Back = S 53° 46' 40.48" E
Ahead = S 0° 49' 36.61" E
Chord Bear = S 27° 18' 08.55" E
 Course from PT BL_A2 to BLA003 S 0^{\circ} 49 36.61" E Dist 102.5430
Point BLA003 N 1,241,083.6010 E 2,359,103.9830 Sta 510+98.62
Ending chain BL_A description
```

Beginning chain BL_B description N 1,241,434.4314 E 2,358,939.7810 Sta 600+00.00 Course from BLB001 to BLB002 N 36° 19' 35.51" E Dist 48.2842N 1,241,473.3318 E 2,358,968.3839 Sta 600+48.28 Course from BLB002 to BLB003 N 36° 19' 35.51" E Dist 4.9914 N 1,241,477.3531 E 2,358,971.3408 Sta 600+53.28 Point BLB003 Course from BLB003 to BLB004 N 36° 19' 35.51" E Dist 94.7676 N 1,241,553.7031 E 2,359,027.4798 Sta 601+48.04 Point BLB004

Beginning chain 1L97_EX

N 1,241,956.7174 E 2,358,318.7732 Sta 941+00.00

Course from 17 to PC IL97_EX_3 S 65° 28' 30.55" E Dist 168.5426

Curve IL97 EX_3
P.I. Station

Delta =
Degree =
Tangent =
Length =
Radius =
External = 948+40.51 N 12° 22' 03.00" (RT) 1° 58' 49.87" 571.9700 1,129.3748 2,892.9656 2,892.9656 1,241,649.3396 E 2,358,992.4778 2,892.9656 56.0003 1,122.2168 54.9368 942+68.54 N 953+97.92 N External 1,241,886.7574 E 1,241,231.7608 E 1,239,254.7913 E C.C. N Back = S 65° 28' 30.55" E Ahead = S 43° 06' 27.55" E Chord Bear = S 54° 17' 29.05" E

Ending chain IL97_EX description

whks

DESIGNED - BJJ REVISED DRAWN -GSJ REVISED OT SCALE = 2400.0000 / ft. HECKED -MRL REVISED PLOT DATE = 8/28/2024 DATE REVISED 8/28/2024

MENARD COUNTY HIGHWAY DEPARTMENT

SECTION COUNTY ALIGNMENT, TIES, & BENCHMARKS DETAILS 21 19-051117-00-RR MENARD 43 WHITES CROSSING AVENUE CONTRACT NO. SCALE: 1" = 100' SHEET 2 OF 2 SHEETS STA. TO STA.

| | | | | NONE |
|----------|------------------------------------|-------|----------|------|
| CODE | | | TOTAL | 0001 |
| NO. | ITEM | UNIT | QUANTITY | S.N. |
| 20200100 | EARTH EXCAVATION | CU YD | 460 | 460 |
| | | | | |
| 28000250 | TEMPORARY EROSION CONTROL SEEDING | POUND | 260 | 260 |
| 28000305 | TEMPORARY DITCH CHECKS | FOOT | 209 | 209 |
| 28000400 | PERIMETER EROSION BARRIER | FOOT | 685 | 685 |
| | | 51011 | | |
| 28000500 | INLET AND PIPE PROTECTION | EACH | 2 | 2 |
| 28100107 | STONE RIPRAP, CLASS A4 | SQ YD | 51 | 51 |
| | | | | |
| 28200200 | FILTER FABRIC | SQ YD | 51 | 51 |
| 35101400 | AGGREGATE BASE COURSE, TYPE B | TON | 586 | 586 |
| 48101200 | AGGREGATE SHOULDERS, TYPE B | TON | 25 | 25 |
| | | | | |
| 50105220 | PIPE CULVERT REMOVAL | FOOT | 128 | 128 |
| 542D0229 | PIPE CULVERTS, CLASS D, TYPE 1 24" | FOOT | 4 | 4 |
| 54261724 | STEEL FLARED END SECTIONS 24" | EACH | 128 | 128 |
| | | | | |
| 53500105 | DELINEATORS | EACH | 4 | 4 |
| 72900100 | METAL POST - TYPE A | FOOT | 28 | 28 |
| | | | | |

| USER NAME = bjohnson | DESIGNED - | BJJ | REVISED | - |
|------------------------------------|------------|-----------|---------|---|
| | DRAWN - | GSJ | REVISED | - |
| PLOT SCALE = 1200:0.0000 ':" / ft. | CHECKED - | MRL | REVISED | - |
| PLOT DATE = 8/28/2024 | DATE - | 8/28/2024 | REVISED | - |
| | | | | |

| MENARD | COUNTY | HIGHWAY | DEPARTMENT | |
|--------|--------|---------|------------|--------|
| | | | | SCALE: |

| | SUMMARY OF QUANTITIES | | | | | | | | | ION | | COUNTY | TOTAL SHEETS | SHEET NO. |
|---|-----------------------|-------|-----|-----------|--------|--|--|----|----------|---------|--|----------|-----------------|--------------|
| WHITES CROSSING AVENUE | | | | | | | | 21 | 19-05111 | 7-00-RR | | MENARD | 43 | 5 |
| | 771 | IIILO | UII | OSSING | AVENUE | | | | | | | CONTRACT | NO. | |
| SCALE: 1" = 50' SHEET 1 OF 2 SHEETS STA. TO STA. ILLINOIS FED. AID PR | | | | D PROJECT | | | | | | | | | | |

CONSTR. CODE

NONE CODE TOTAL 0001 ITEM UNIT QUANTITY S.N. NO. X2501000 SEEDING, CLASS 2 (SPECIAL) ACRE 1 L SUM X7011800 TRAFFIC CONTROL AND PROTECTION, STANDARD BLR 21 1 X7240600 REMOVE AND RE-ERECT EXISTING SIGN EACH 5 5 Z0013798 CONSTRUCTION LAYOUT L SUM 1 Z0048665 RAILROAD PROTECTIVE LIABILITY INSURANCE L SUM 1 1 LR403600 SEAL COAT AGGREGATE TON 16 16 XX009171 BITUMINOUS MATERIALS (PRIME COAT) GALLON 309 309 STABILIZED SHOULDER (SPECIAL) SQ YD 52 52

design firm
no. 184001036 whks

engineers + planners + land surveyors

| USER NAME = bjohnson | DESIGNED - | BJJ | REVISED | - |
|------------------------------------|------------|-----------|---------|---|
| | DRAWN - | GSJ | REVISED | - |
| PLOT SCALE = 1200:0.0000 ':" / ft. | CHECKED - | MRL | REVISED | - |
| PLOT DATE = 8/28/2024 | DATE - | 8/28/2024 | REVISED | - |
| | | | | |

| | SI | JMM | ٩R١ | OF QU | ANTITIES |
|-----------------|---------|-------|-----|---------|----------|
| | WI | HITES | C | ROSSING | AVENUE |
| SCALE: 1" = 50' | SHEET 2 | OF | 2 | SHEETS | STΔ |

CONSTR. CODE

| T.R. RTE | SECTION | | COUNTY | TOTAL SHEETS | SHEET NO. |
|-------------|-----------------|--------|------------|-----------------|--------------|
| 21 | 19-051117-00-RI | 3 | MENARD | 43 | 6 |
| | | | CONTRACT | NO. | |
| | ILLINOIS | FED. A | ID PROJECT | | |

TO STA.

| | 20200100 | 20200100 FOR INFORMATION ONLY | | | | |
|---|------------|-------------------------------|------------|--------------|--|--|
| | | EXCAVATION TO BE | | EARTHWORK | | |
| LOCATION | *EARTH | USED IN EMBANKMENT | EMBANKMENT | BALANCE | | |
| LOCATION | EXCAVATION | (ADJUSTED FOR SHRINKAGE) | (FILL) | WASTE(+) AND | | |
| | | (EXC. x 0.75) | | SHORTAGE (-) | | |
| | CU. YD. | CU. YD. | CU. YD. | CU. YD. | | |
| STA. 503+50.00 TO STA. 508+15.00 (BASELINE A) | 375 | 280 | 145 | 135 | | |
| STA. 600+08.00 TO STA. 601+35.04 (BASELINE B) | 45 | 35 | 120 | - 85 | | |
| STA. 947+78.31 TO STA. 949+69.43 (BASELINE IL 97) | 40 | 30 | 80 | - 50 | | |
| TOTAL | 460 | 345 | 345 | 0 | | |

EARTH EXCAVATION SHRINKAGE FACTOR = 25%

*BITUMINOUS ROADWAY SURFACE TO BE REMOVED WILL BE INCLUDED IN EARTH EXCAVATION QUANTITY.

28000250 TEMPORARY EROSION CONTROL SEEDING

| IL 97 A | T WHITES CRO | SSING | | | | | POUND |
|------------------------------------|--------------|-------|----|-----------|--|--|-------|
| LT | 503+50.00 | TO | LT | 506+85.00 | | | 80 |
| RT | 503+50.00 | TO | RT | 506+85.00 | | | 45 |
| LT | 506+85.00 | TO | LT | 508+15.00 | | | 30 |
| RT | 506+85.00 | TO | RT | 508+15.00 | | | 20 |
| LT | 600+55.00 | TO | LT | 601+35.00 | | | 65 |
| RT | 600+55.00 | TO | RT | 601+35.00 | | | 20 |
| NOTE: ASSUMES 3 APPLICATIONS TOTAL | | | | | | | 260 |

28000400 PERIMETER EROSION BARRIER

| IL 97 A | T WHITES CRO | SSING | | | | FOOT |
|---------|--------------|-------|----|-----------|-------|------|
| LT | 503+50.00 | TO | LT | 504+50.00 | | 130 |
| RT | 503+50.00 | TO | RT | 506+00.00 | | 235 |
| LT | 507+00.00 | ТО | LT | 508+15.00 | | 130 |
| LT | 600+50.00 | ТО | LT | 601+35.00 | | 95 |
| RT | 600+50.00 | ТО | RT | 601+35.00 | | 95 |
| | | | | | TOTAL | 685 |

28000305 TEMPORARY DITCH CHECKS

| IL 97 AT | WHITES CROSSING | | FOOT |
|----------|-----------------|-------|------|
| LT | 507+51.00 | | 11 |
| LT | 507+84.00 | | 11 |
| LT | 505+90.00 | | 11 |
| LT | 504+40.00 | | 11 |
| LT | 504+10.00 | | 11 |
| LT | 503+80.00 | | 11 |
| RT | 503+80.00 | | 11 |
| RT | 504+10.00 | | 11 |
| RT | 504+40.00 | | 11 |
| RT | 504+70.00 | | 11 |
| RT | 505+30.00 | | 11 |
| LT | 600+75.00 | | 11 |
| LT | 601+00.00 | | 11 |
| RT | 948+75.00 | | 11 |
| RT | 948+50.00 | | 11 |
| RT | 948+25.00 | | 11 |
| RT | 600+75.00 | | 11 |
| RT | 601+00.00 | | 11 |
| RT | 949+50.00 | | 11 |
| | · | TOTAL | 209 |

28000500 INLET AND PIPE PROTECTION

| IL 97 AT | WHITES CROSSING | | EACH |
|----------|-----------------|-------|------|
| RT | 505+00.00 | | 1 |
| RT | 600+36.00 | | 1 |
| | | TOTAL | 2 |

28100107 STONE RIPRAP, CLASS A4

| IL 97 AT WHITES CROSSING | | | | | | | |
|--------------------------|-----------|----|----|-----------|--|-------|----|
| LT | 504+75.00 | ТО | LT | 505+10.00 | | | 51 |
| | | | | | | TOTAL | 51 |

28200200 FILTER FABRIC

| 20200200 TIETER TABINE | | | | | | | | | |
|------------------------------|-------|----|--|--|--|--|--|--|--|
| IL 97 AT WHITES CROSSING | | | | | | | | | |
| LT 504+75.00 TO LT 505+10.00 | | 51 | | | | | | | |
| | TOTAL | 51 | | | | | | | |

35101400 AGGREGATE BASE COURSE, TYPE B

| IL 97 A | T WHITES CRO | SSING | | | | TON |
|---------|--------------|-------|----|-----------|-------|-----|
| CL | 503+50.00 | TO | CL | 504+00.00 | | 43 |
| CL | 504+00.00 | TO | CL | 507+65.00 | | 308 |
| CL | 507+65.00 | TO | CL | 508+15.00 | | 39 |
| CL | 600+08.00 | TO | CL | 600+38.28 | | 74 |
| CL | 600+47.28 | ТО | CL | 600+90.00 | | 37 |
| CL | 600+90.00 | TO | CL | 601+25.00 | | 76 |
| | | | | | TOTAL | 577 |

48101200 AGGREGATE SHOULDERS, TYPE B

| IL 97 AT WHITES CROSSING | | | | | | | | TON |
|--------------------------|------------------------------|--|--|--|--|--|-------|-----|
| | LT 947+78.31 TO LT 949+69.45 | | | | | | 25 | |
| | | | | | | | TOTAL | 25 |

STABILIZED SHOULDER (SPECIAL)

| IL 97 AT WHITES CROSSING | | | | | | | | SQ YD |
|--------------------------|----|-----------|----|----|-----------|--|-------|-------|
| | LT | 947+78.31 | TO | LT | 949+69.45 | | | 52 |
| | | | | | | | TOTAL | 52 |

50105220 PIPE CULVERT REMOVAL

| IL 97 AT WHITES CROSSING | | FOOT |
|--------------------------|-------|------|
| LT/RT 97+48.00 | | 43 |
| LT/RT 98+00.00 | | 85 |
| | TOTAL | 128 |

542D0229 PIPE CULVERTS, CLASS D, TYPE 1 24"

| IL 97 AT WHITES CROSSING | | FOOT |
|--------------------------|-------|------|
| LT/RT 505+00.00 | | 54 |
| LT/RT 600+36.00 | | 80 |
| | TOTAL | 134 |

54261724 STEEL FLARED END SECTIONS 24"

| 0 1201727 01221 127712 2112 02 | | |
|--------------------------------|-------|------|
| IL 97 AT WHITES CROSSING | | EACH |
| LT/RT 505+00.00 | | 2 |
| LT/RT 600+36.00 | | 2 |
| | TOTAL | _ 4 |

esign firm
o. 184001036

whks

engineers + planners + land surveyors

| JSER NAME = bjohnson | DESIGNED - | BJJ | REVISED - |
|------------------------------------|------------|-----------|-----------|
| | DRAWN - | GSJ | REVISED - |
| PLOT SCALE = 1200:0.0000 ':" / ft. | CHECKED - | MRL | REVISED - |
| PLOT DATE = 8/28/2024 | DATE - | 8/28/2024 | REVISED - |

| | S | CHEDULE | OF QUA | ANTITIES | | T.R. RTE | SEC. | TION | | COUNTY | TOTAL SHEETS | SHEET NO. |
|------------------------|---------|-----------|--------|----------|---------|-----------------|------|----------|--------|------------|-----------------|--------------|
| WHITES CROSSING AVENUE | | | | | 21 | 19-051117-00-RR | | MENARD | 43 | 7 | | |
| | ** | IIIILO OI | | | - | | | | | CONTRACT | NO. | |
| SCALE: 1" = 50' | SHEET 1 | OF 2 | SHEETS | STA. | TO STA. | | | ILLINOIS | FED. A | ID PROJECT | | |

63500105 DELINEATORS

| IL 97 AT WHITES CROSSING | | | | | |
|---|-------|---|--|--|--|
| LT/RT 505+00.00 | | 2 | | | |
| LT/RT 600+36.00 | | 2 | | | |
| USE TWO-SIDED REFLECTORS AT ALL LOCATIONS | TOTAL | 4 | | | |

72900100 METAL POST - TYPE A

| IL 97 AT | WHITES CROSSING | | FOOT |
|----------|-----------------|-------|------|
| LT | 505+00.00 | | 7 |
| RT | 505+00.00 | | 7 |
| LT | 600+36.00 | | 7 |
| RT | 600+36.00 | | 7 |
| | | TOTAL | 28 |

X2501000 SEEDING, CLASS 2 (SPECIAL)

| IL 97 A | T WHITES CRO | SSING | ı | | | ACRE |
|---------|--------------|-------|----------|---------------|-------|------|
| LT | 503+50.00 | TO | LT | 506+85.00 | | 0.27 |
| RT | 503+50.00 | TO | RT | 506+85.00 | | 0.15 |
| LT | 506+85.00 | TO | LT | 508+15.00 | | 0.09 |
| RT | 506+85.00 | TO | RT | 508+15.00 | | 0.06 |
| LT | 600+55.00 | TO | LT | 601+35.00 | | 0.22 |
| RT | 600+55.00 | TO | RT | 601+35.00 | | 0.06 |
| TOTAL | SEEDING AREA | ROU | NDED FOR | PROPER D.O.A. | TOTAL | 1.00 |

X7011800 TRAFFIC CONTROL AND PROTECTION, STANDARD BLR 21

| IL 97 AT WHITES CROSSING | | | |
|--------------------------|-------|---|--|
| | TOTAL | 1 | |

X7240600 REMOVE AND RE-ERECT EXISTING SIGN

| IL 97 | AT WHITES CROSSING | | EACH |
|-------|--------------------|-------|------|
| LT | 98+40.00 | | 1 |
| LT | 98+50.00 | | 1 |
| RT | 98+50.00 | | 1 |
| RT | 99+71.00 | | 1 |
| RT | 99+76.00 | | 1 |
| | | TOTAL | 5 |

Z0013798 CONSTRUCTION LAYOUT

| IL 97 AT WHITES CROSSING | | | | | |
|--------------------------|-------|---|--|--|--|
| | TOTAL | 1 | | | |

Z0048665 RAILROAD PROTECTIVE LIABILITY INSURANCE

| IL 97 AT WHITES CROSSING | | L SUI |
|--------------------------|-------|-------|
| | TOTAL | 1 |

LR403600 SEAL COAT AGGREGATE

| IL 97 A | T WHITES CRO | SSING | | | | TON |
|---------|--------------|-------|----|-----------|-------|-----|
| CL | 503+50.00 | TO | CL | 504+00.00 | | 2 |
| CL | 504+00.00 | ТО | CL | 507+65.00 | | 8 |
| CL | 507+65.00 | ТО | CL | 508+15.00 | | 1 |
| CL | 600+08.00 | ТО | CL | 600+38.28 | | 2 |
| CL | 600+47.28 | TO | CL | 600+90.00 | | 1 |
| CL | 600+90.00 | ТО | CL | 601+25.00 | | 2 |
| | | | | | TOTAL | 16 |

XX009171 BITUMINOUS MATERIALS (PRIME COAT)

| IL 97 A | T WHITES CRO | SSING | | | | GALLON |
|---------|--------------|-------|----|-----------|-------|--------|
| CL | 503+50.00 | TO | CL | 504+00.00 | | 23 |
| CL | 504+00.00 | TO | CL | 507+65.00 | | 163 |
| CL | 507+65.00 | TO | CL | 508+15.00 | | 21 |
| CL | 600+08.00 | TO | CL | 600+38.28 | | 41 |
| CL | 600+47.28 | TO | CL | 600+90.00 | | 19 |
| CL | 600+90.00 | TO | CL | 601+25.00 | | 42 |
| | | | | | TOTAL | 309 |

design firm
no. 184001036 **whks**engineers + planners + land surveyors


| USER NAME = bjohnson | DESIGNED | - | BJJ | REVISED | = |
|------------------------------------|----------|---|-----------|---------|---|
| | DRAWN | - | GSJ | REVISED | = |
| PLOT SCALE = 1200:0.0000 ':" / ft. | CHECKED | - | MRL | REVISED | = |
| PLOT DATE = 8/28/2024 | DATE | - | 8/28/2024 | REVISED | - |


SCALE: 1" = 50'

| | SCHEDULE OF QUANTITIES | | | | | T.R. RTE. | SECTION | | COUNTY | TOTAL SHEETS | SHEET NO. | | |
|------------------------|------------------------|----|---|--------|------|--------------|-----------------|--|----------|-----------------|--------------|--|--|
| WHITES CROSSING AVENUE | | | | | | 21 | 19-051117-00-RR | | MENARD | 43 | 8 | | |
| | | | | | | | | | | CONTRACT | NO. | | |
| | SHEET 2 | OF | 2 | SHEETS | STA. | TO STA. | | | ILLINOIS | FED. A | ID PROJECT | | |

LEGEND

- 1 EX PAVEMENT
- 2 EARTH SURFACE
- 3 EX AGGREGATE SHOULDERS
- (4) EX HMA SHOULDER
- 5) OIL AND CHIP (A-1 SURFACE)
- 6 8" AGGREGATE BASE
- (7) AGGREGATE SHOULDERS, TYPE B, 8"
- 8 PR STABLIZED SHOULDER (SPECIAL), 8"
- 9 FURNISHED EXCAVATION

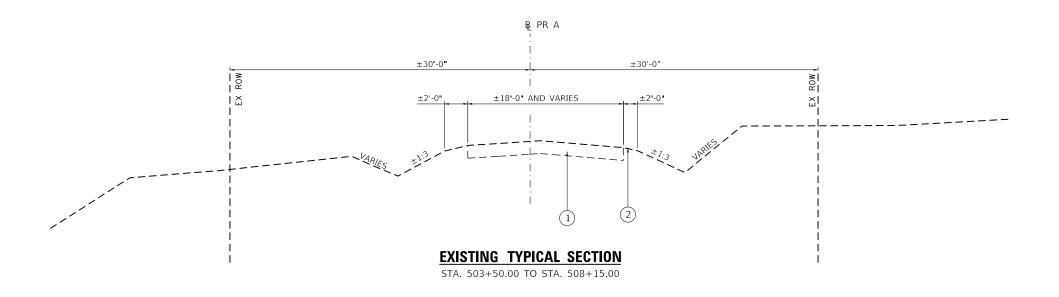

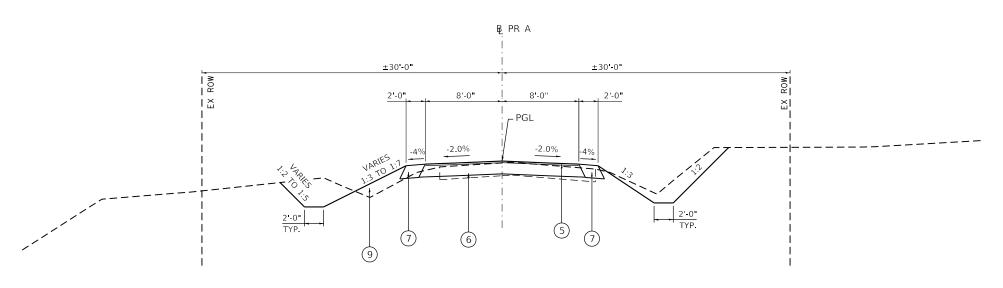

PROPOSED TYPICAL SECTION

STA. 503+50.00 TO STA. 508+15.00

| sign firm 18400103 | whks |
|-----------------------|---------------------------------------|
| | engineers + planners + land surveyors |


| USER NAME = bjohnson | DESIGNED - | BJJ | REVISED - |
|-------------------------------|------------|-----------|-----------|
| | DRAWN - | GSJ | REVISED - |
| PLOT SCALE = 120.0000 ' / ft. | CHECKED - | MRL | REVISED - |
| PLOT DATE = 8/28/2024 | DATE - | 8/28/2024 | REVISED - |

| MENARD | COUNTY | HIGHWAY | DEPARTMENT |
|--------|--------|---------|------------|
| | | | |

| | TYPICAL SECTIONS WHITES CROSSING AVENUE | | | | | | | SECTION | COUNTY | TOTAL SHEETS | SHEET NO. |
|--|---|---------|------|--------|------|---------|--|---------------------------|----------|-----------------|--------------|
| | | | | | | | | 19-051117-00-RR | MENARD | 43 | 9 |
| | | | | | | | | | CONTRACT | ΓNO. | |
| | SCALE: 1" = 10' | SHEET 1 | OF 3 | SHEETS | STA. | TO STA. | | ILLINOIS FED. AID PROJECT | | | |


LEGEND

- 1 EX PAVEMENT
- 2 EARTH SURFACE
- 3 EX AGGREGATE SHOULDERS
- (4) EX HMA SHOULDER
- 5 OIL AND CHIP (A-1 SURFACE)
- 6 8" AGGREGATE BASE
- (7) AGGREGATE SHOULDERS, TYPE B, 8"
- 8 PR STABLIZED SHOULDER (SPECIAL), 8"
- 9 FURNISHED EXCAVATION

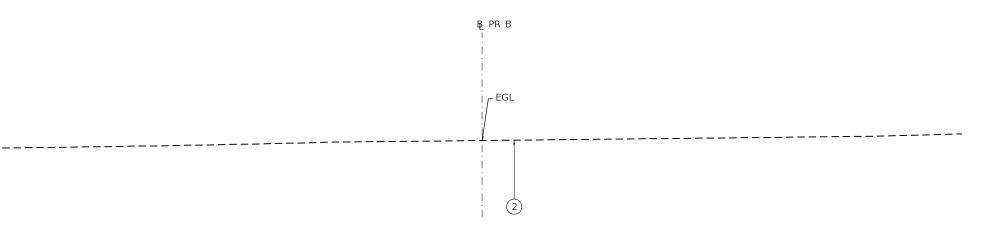

EXISTING TYPICAL SECTION

STA. 600+08.00 TO STA. 601+35.04 (LOOKING NORTHEAST)

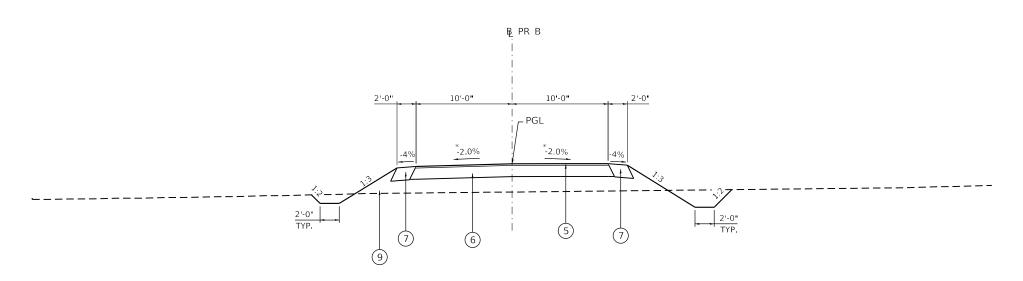

PROPOSED TYPICAL SECTION

STA. 600+08.00 TO STA. 601+35.04 (LOOKING NORTHEAST)

*NOTE: ENSURE ROADWAY CROWN TRANSITIONS TO ZERO CROWN WITH 12' OF THE TRACK CENTERLINE.

SCALE: 1" = 10'

| design firm no. 184001036 | whle |
|------------------------------|---------------------------------------|
| 110. 104001000 | whks |
| | engineers + planners + land surveyors |
| | |


| USER NAME = bjohnson | DESIGNED | - | BJJ | REVISED - | |
|-------------------------------|----------|---|-----------|-----------|--|
| | DRAWN | - | GSJ | REVISED - | |
| PLOT SCALE = 120.0000 ' / ft. | CHECKED | - | MRL | REVISED - | |
| PLOT DATE = 8/28/2024 | DATE | - | 8/28/2024 | REVISED - | |


| MENARD | COUNTY | HIGHWAY | DEPARTMENT |
|--------|--------|---------|------------|
| | | | |

| TYPICAL SECTIONS | | | | | T.R. RTE | SECTION | | COUNTY | TOTAL SHEETS | SHEET NO. | |
|------------------------|----------|--------|-----------|-----------------|-----------------------|------------------------|---|---|---|--|--|
| WHITES CROSSING AVENUE | | | | | | 21 | 19-051117-00-RR | | MENARD | 43 | 10 |
| | | | | | | | | | CONTRACT | NO. | |
| ET 2 | OF | 3 | SHEETS | STA. | TO STA. | | ILLINOIS | FED. AI | D PROJECT | | |
| | W | WHITES | WHITES CR | WHITES CROSSING | WHITES CROSSING AVENU | WHITES CROSSING AVENUE | TYPICAL SECTIONS RTE. WHITES CROSSING AVENUE | TYPICAL SECTIONS WHITES CROSSING AVENUE 21 19-051117-00-RR | TYPICAL SECTIONS WHITES CROSSING AVENUE 21 19-051117-00-RR | TYPICAL SECTIONS WHITES CROSSING AVENUE REE. SECTION COUNTY 21 19-051117-00-RR MENARD CONTRACT | TYPICAL SECTIONS WHITES CROSSING AVENUE 21 19-051117-00-RR MENARD 43 CONTRACT NO. |



- 1 EX PAVEMENT
- 2 EARTH SURFACE
- (3) EX AGGREGATE SHOULDERS
- (4) EX HMA SHOULDER
- 5 OIL AND CHIP (A-1 SURFACE)
- 6 8" AGGREGATE BASE
- (7) AGGREGATE SHOULDERS, TYPE B, 8"
- (8) PR STABLIZED SHOULDER (SPECIAL), 8"
- 9 FURNISHED EXCAVATION

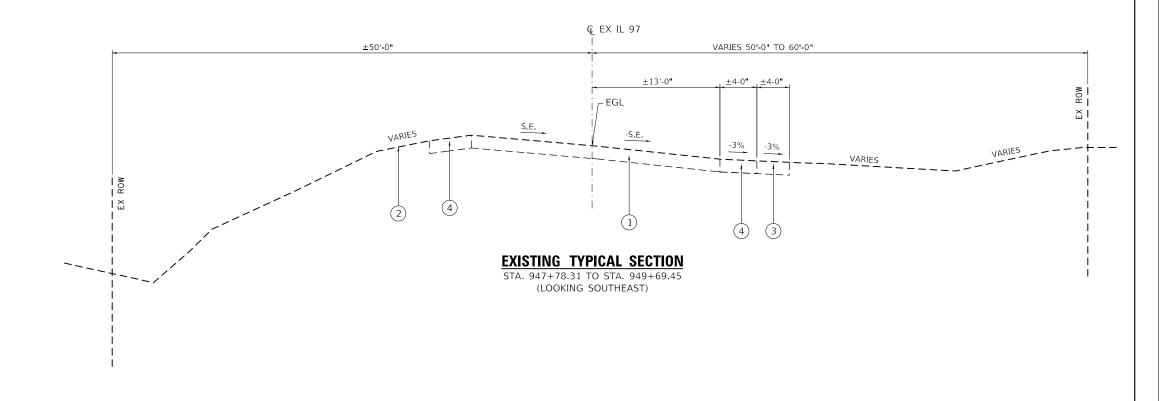

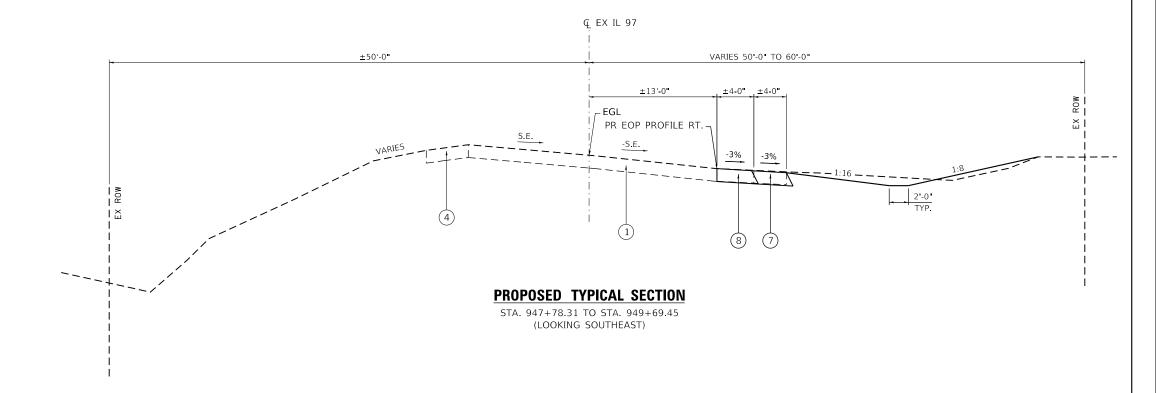

esign firm
o. 184001036 whks

engineers + planners + land surveyors

| DESIGNED - BJJ | REVISED - | DRAWN - GSJ | REVISED - | DATE - 8/28/2024 | REVISED - | DATE - 8/28/2024 | REVISED - | DATE - B/28/2024 | DATE - B/28/2024 | REVISED - | DATE - B/28/2024 | DATE - B/28/2024 | REVISED - | DATE - B/28/2024 | DATE

MENARD COUNTY HIGHWAY DEPARTMENT

